
-6

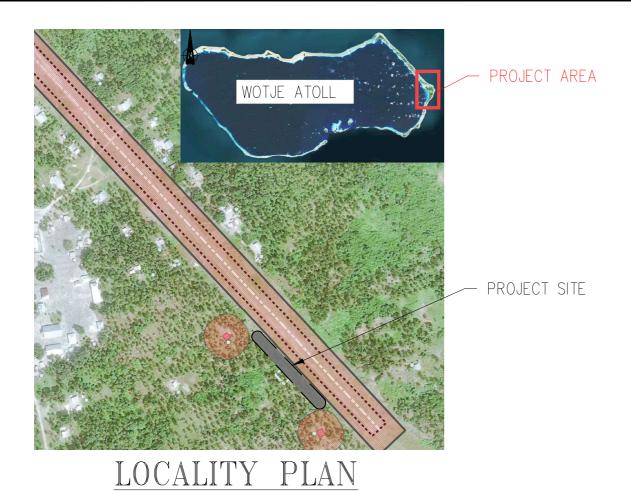

MANAGING COASTAL AQUIFERS (MCAP), WOTJE **PROJECT** 

**LOCATION** WOTJE, REPUBLIC of MARSHALL ISLAND

JOB NO 22307117

**CLIENT** 



CONSULTANT:



	DRAWING SHEET SCHEDULES			
SHEET No.	SHEET TITLE	REV	DATE	
G-001	COVER SHEET	OA	5-0ct-23	
A-001	GALLERY TANK OVERHEAD FLOOR PLAN, BEAM LAYOUT AND SECTIONS PIPEWORK DETAILS	OA	5-0ct-23	[
A-002	FOUNDATION PLAN	OA	5-0ct-23	
A-003	HEADER TANK, INLET PIPE WORK ELEVATIONS (BE & SE1)	OA	5-0ct-23	
A-004	HEADER TANK, INLET PIPE WORK ELEVATIONS (FE & SE2)	OA	5-0ct-23	
A-005	GALLERY TANK SECTION	OA	5-0ct-23	
A-006	GENERAL PIPE WORK DETAILS	0A	5-0ct-23	
A-007	GALLERY PUMP PIPE WORK SECTION (TYP.)	0A	5-0ct-23	1
A-008	GALLERY SECTION AND DETAIL	0A	5-0ct-23	
A-009	COLUMN STRUCTURAL DETAILS, PAD FOOTINGS & TYPICAL SECTIONS	OA	5-0ct-23	
A-010	COMMUNITY FILLING POINT SITE PLAN & TYPICAL SECTION	OA	5-0ct-23	
A-011	SAFETY ACCESS CAGE LADDER AND TYPICAL HANDRAIL ELEVATIONS, SECTIONS AND DETAILS	OA	5-0ct-23	


SCALE: NTS

Design amended to exclude

Design amended to exclude Design amended to exclude Design amended to exclude Design amended to exclude

Design amended to exclude

Design amended to exclude

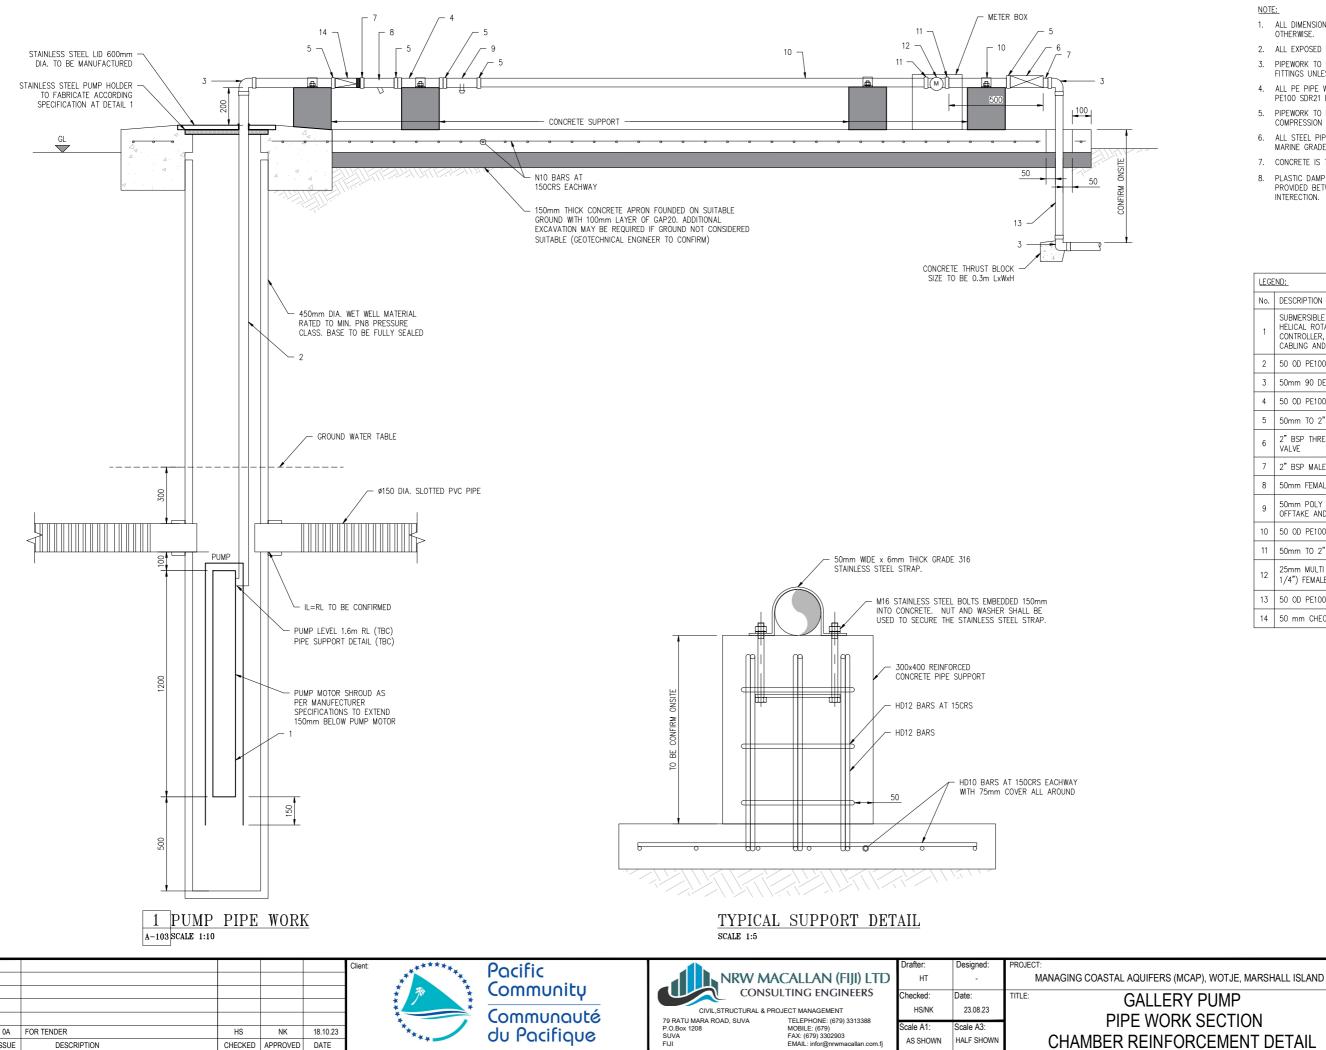

du Pacifique

0A FOR TENDER

DESCRIPTION

ISSUE

NK

CHECKED APPROVED DATE

18.10.23

NOTE:

- 1. ALL DIMENSION ARE IN MILLIMETERS UMLESS NOTED OTHERWISE.
- 2. ALL EXPOSED PIPELINE ARE TO BE POLYETHYLENE.
- 3. PIPEWORK TO CONNECTED WITH PE COMPRESSION
- 4. ALL PE PIPE WORK AND FITTINGS TO BE CLASS PE100 SDR21 P8, UNLESS NOTED OTHERWISE.
- 5. PIPEWORK TO BE CONNECTED WITH APPROVED COMPRESSION FITTINGS.
- 6. ALL STEEL PIPE WORK AND FITTINGS TO BE 316 MARINE GRADE UNLESS NOTED OTHERWISE.
- 7. CONCRETE IS TO BE 30MPa STRENGTH.
- 8. PLASTIC DAMP PROOF COURSE (DPC) SHEETING PROVIDED BETWEEN ALL CONCRETE AND SOIL

No.	DESCRIPTION	
1	SUBMERSIBLE PUMP, LORENTZ PS2-1800 HRE 32 HELICAL ROTAR PUMP, EC DRIVE AND CONTROLLER, ASSOCIATEDFITTINGS INCLUDING CABLING AND ACCESSORIES	
2	50 OD PE100 SDR21 P8 PIPE	
3	50mm 90 DEG. POLYETHYLENE ELBOW SOCKET	
4	50 OD PE100 SDR21 P8 PIPE	
5	50mm TO 2" BSP POLYETHYLENE MALE ADAPTOR	
6	2" BSP THREADED FEMAIL LOCKABLE BRASS BALL VALVE	
7	2" BSP MALE THREADED NIPPLE	
8	50mm FEMALE POLY Y-STRAINER WITH SS MESH	
9	50mm POLY FEMALE TEE WITH 1" MALE THREAD OFFTAKE AND BIP TAP	
10	50 OD PE100 SDR21 P8 PIPE	
11	50mm TO 2" BSP POLYETHYLENE MALE ADAPTOR	
12	25mm MULTI JET FLOE METER WITH 30mm (1 & 1/4") FEMALE THREADED EACH SIDE	
13	50 OD PE100 SDR21 P8 PIPE	
14	50 mm CHECK VALVE	

-6

-8

-8

-2

-09

-22

-8

--6

E<sub>o</sub>

JOB. NO:


22307117 REV. NO:


**GALLERY PUMP** PIPE WORK SECTION CHAMBER REINFORCEMENT DETAIL


AS SHOWN

HALF SHOWN

DRAWING. NO: A-007

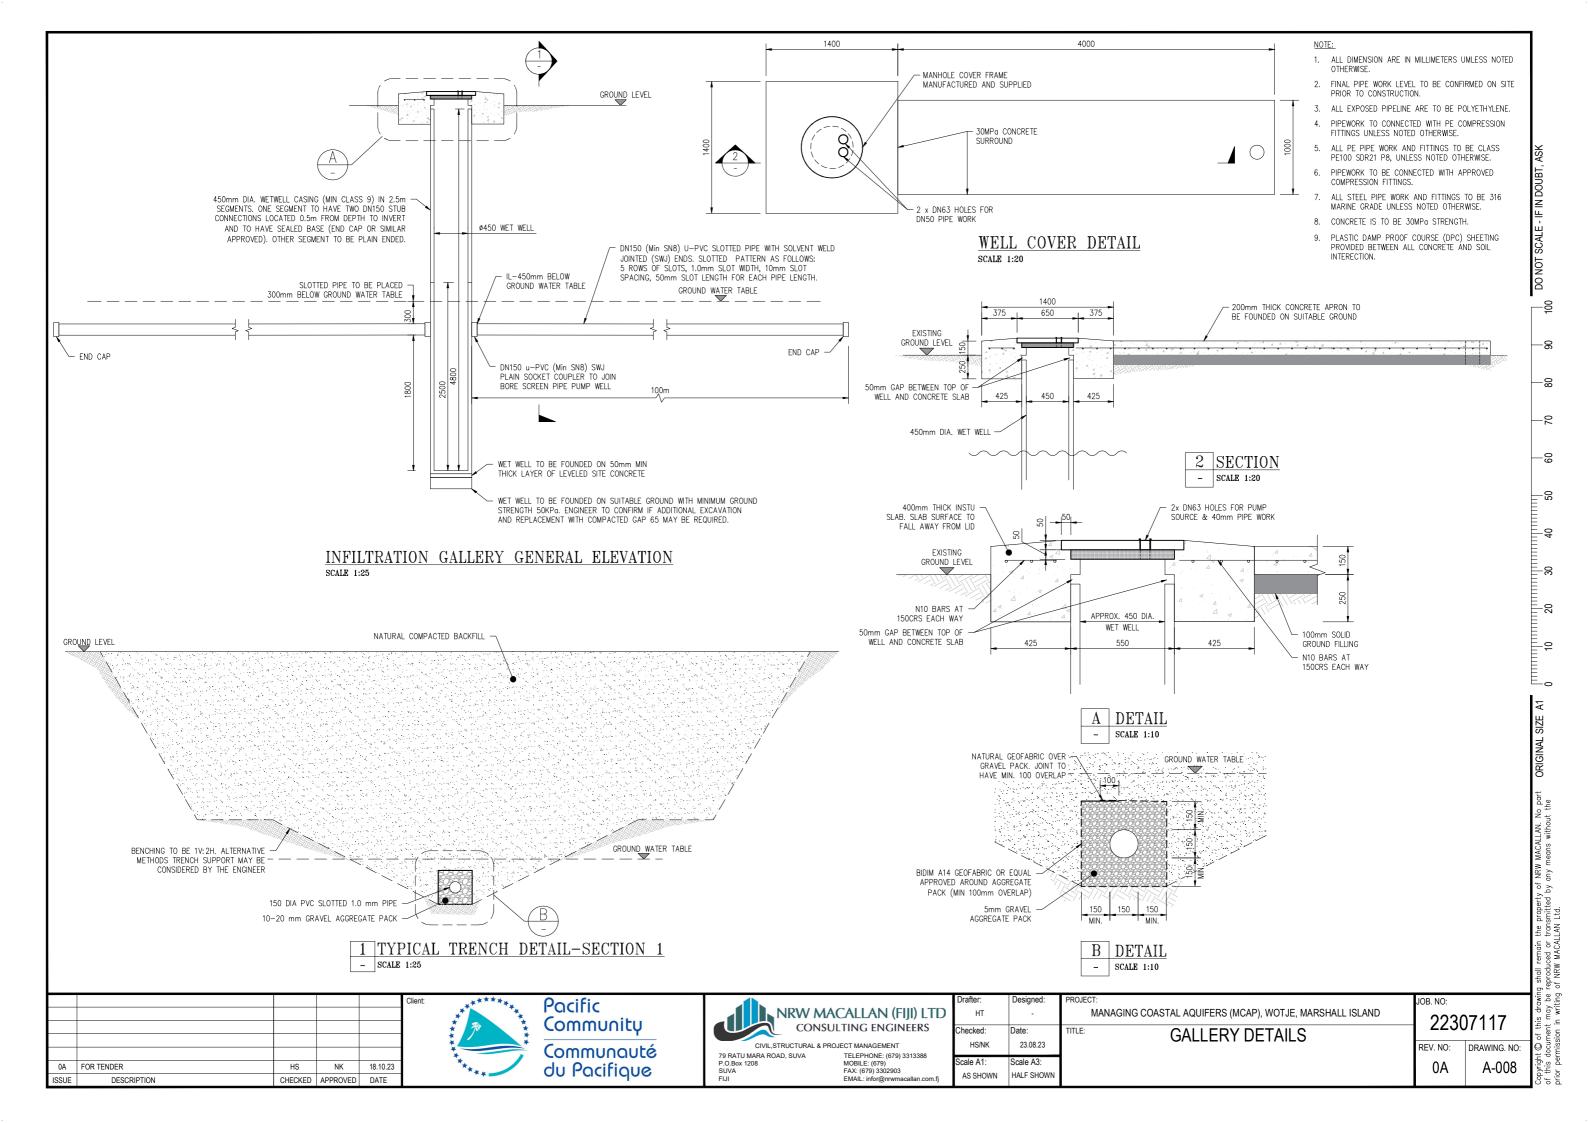

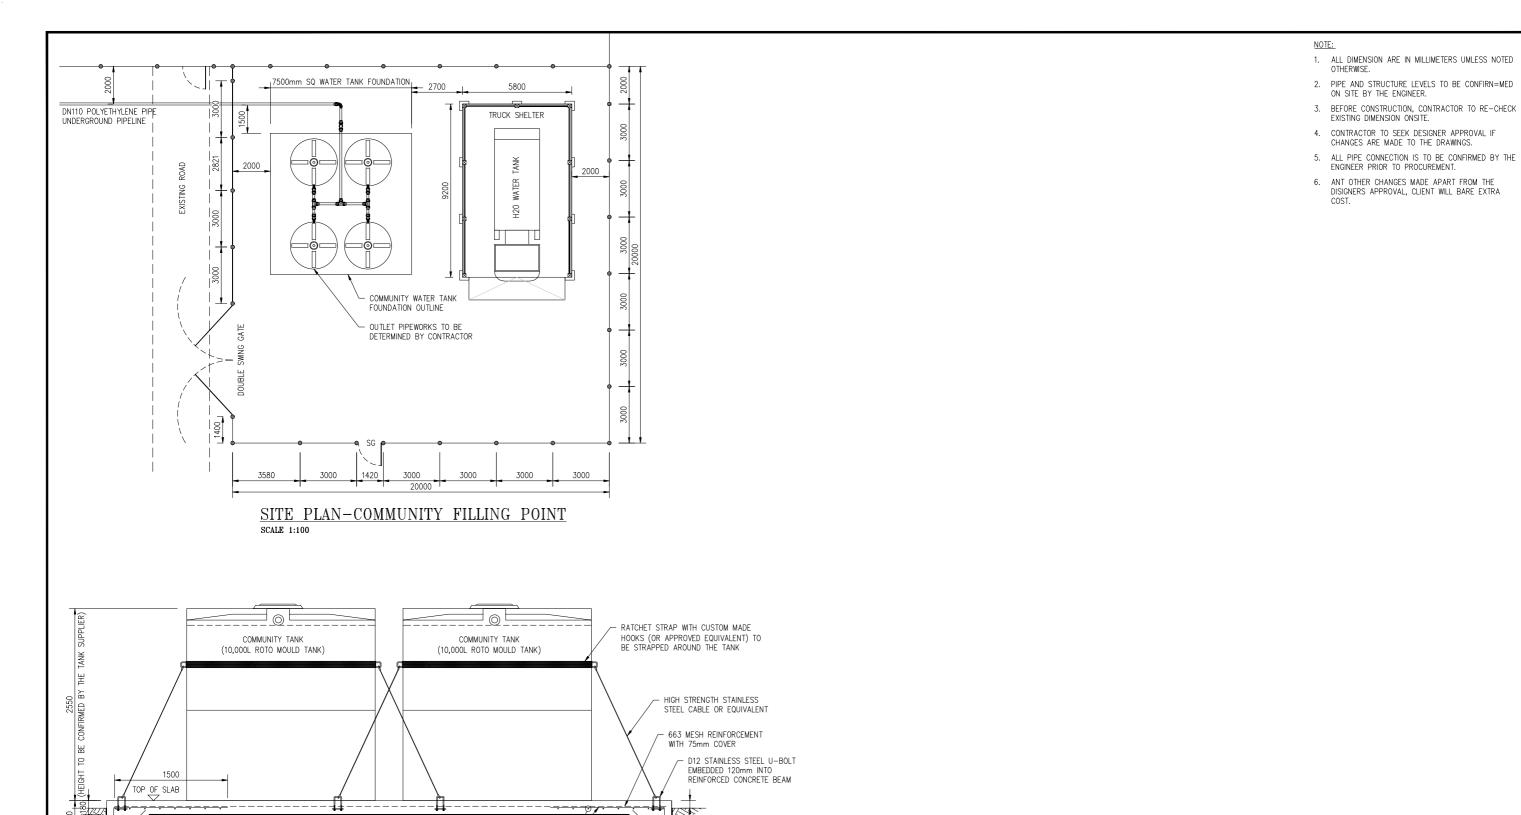

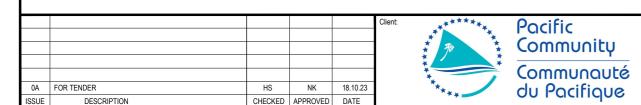

SCALE 1:25

TYPICAL TANK ELEVATION

0.2mm DPC — 50mm SAND BLINDING — D12 BAR AT

2 No. HD12 BAR -

200CRS BOTHWAYS



CIVIL, STRUCTURAL & PROJECT MANAGEMENT			
79 RATU MARA ROAD, SUVA	TELEPHONE: (679) 331338		
P.O.Box 1208	MOBILE: (679)		
SUVA	FAX: (679) 3302903		
FIJI	EMAIL: infor@nrwmacallan.o		

	Drafter:	Designed:	PROJECT:
)	НТ	-	MANAGING COASTAL AQUIFERS (MCAP), WOTJE, MARSHALL ISLAND
	Checked: HS/NK	Date: 23.08.23	TITLE: COMMUNITY FILLING POINT
	Scale A1:	Scale A3:	SITE PLAN
	AS SHOWN	HALF SHOWN	TYPICAL SECTIONS

		ng shall re reproduce
JOB. NO:		rawir y be
2230	7117	of this dro nent may
REV. NO:	DRAWING. NO:	t © of ti Jocument
0A	A-010	pyrigh this (

-6

-8

-8

-2

-09

-22

-6

E-8

2=

19

E<sub>o</sub>